# PROPOSED SECOND UNIT

123 ANYWHERE STREET, BRAMPTON, ONTARIO

#### **DRAWING LIST:**

PROVIDE SURVEY (FOR REFERENCE ONLY)

| A101 | SAMPLE SITE PLAN                  |
|------|-----------------------------------|
| A102 | SAMPLE EXISTING BASEMENT PLAN     |
| A103 | SAMPLE BASEMENT PLAN - OPTION 'A' |
| A104 | SAMPLE BASEMENT PLAN - OPTION 'B' |
| A105 | SAMPLE BASEMENT PLAN - OPTION 'C' |
| A106 | SAMPLE GROUND FLOOR PLAN          |
| A107 | SAMPLE SECOND FLOOR PLAN          |

A201 SAMPLE SIDE ELEVATION A202 SAMPLE REAR ELEVATION


A301 SAMPLE SECTIONS
A302 WALL/ CEILING DETAILS

A401 WINDOW DETAILS

A402 FIRE BLOCKING DETAILS

P101 SAMPLE BASEMENT PLAN - PLUMBING P102 SAMPLE BASEMENT PLAN - RISERS

123 ANYWHERE STREET, BRAMPTON

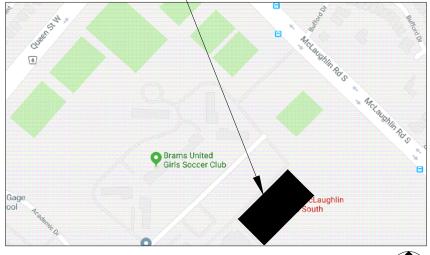

LOCATION PLAN N.T.S.



CHANGE OF USE - TWO UNIT HOUSE SAMPLE SITE PLAN
JUNE 8th, 2019

BRAMPTON

brampton.ca


Flower City

CITY OF BRAMPTON, ON


8850 McLaughlin RD. UNIT #1
PLANNING AND INFRASTRUCTURE SERVICES

EGRESS OPTION 'C' IS ONLY AVAILABLE AS A COMPLIANCE ALTERNATIVE WHERE ZONING REQUIREMENTS CANNOT BE ACHIEVED FOR


**EGRESS IN OPTIONS 'A' OR 'B'** 

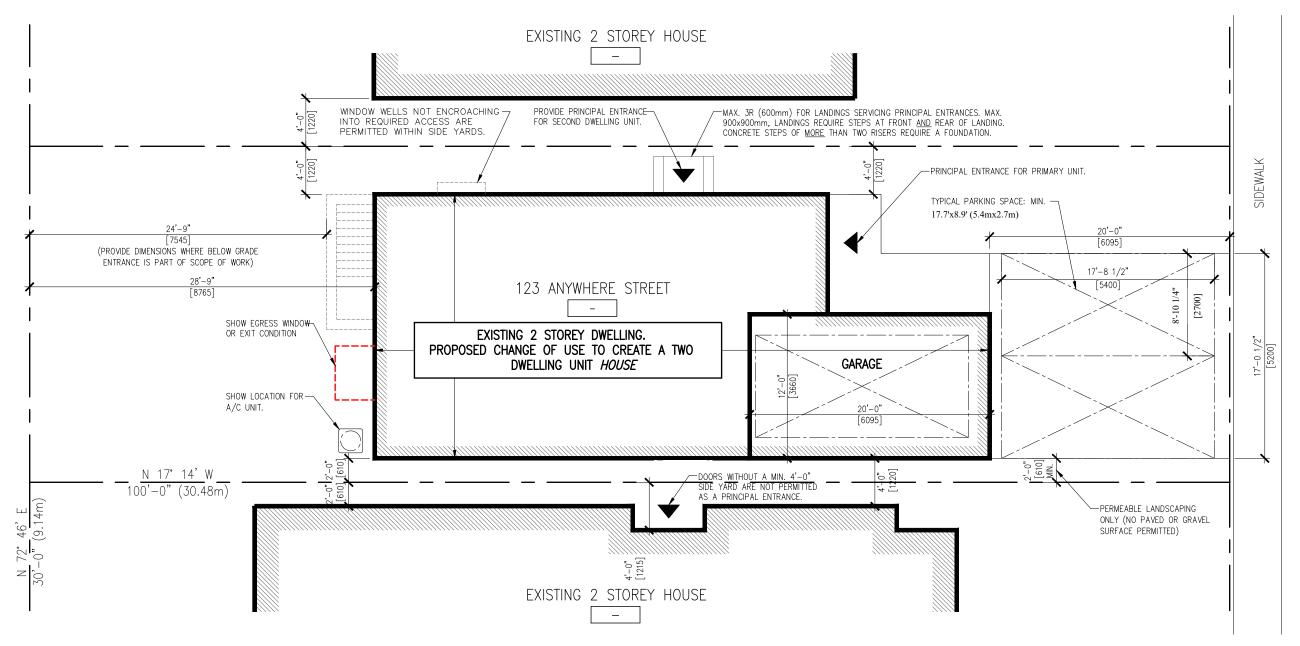




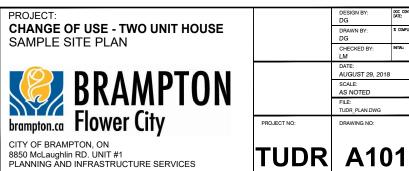

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|-------------|--------------------------|-----------------------|
|             | DRAWN BY:<br>DG          | % COMPLETE:           |
|             | CHECKED BY:<br>LM        | INTIAL:               |
|             | DATE:<br>AUGUST 29, 2018 |                       |
|             | SCALE:<br>AS NOTED       |                       |
|             | FILE:<br>TUDR_PLAN.DWG   |                       |
| PROJECT NO: | DRAWING NO:              |                       |

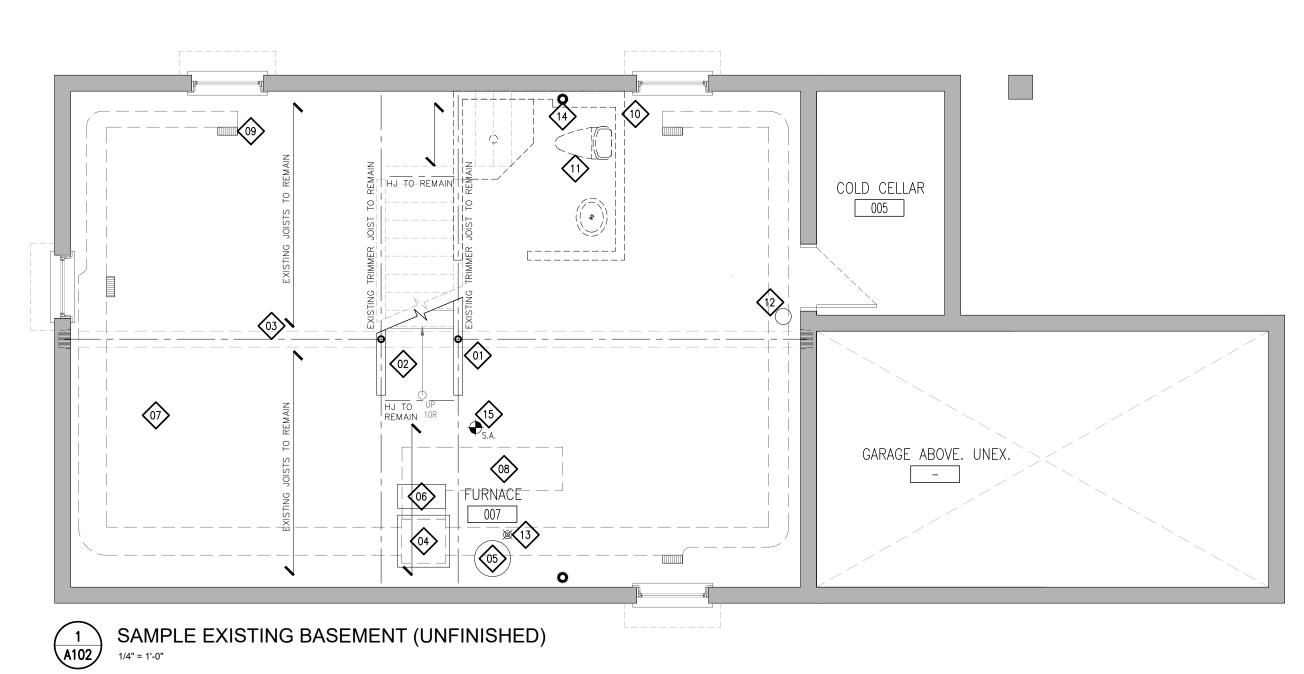

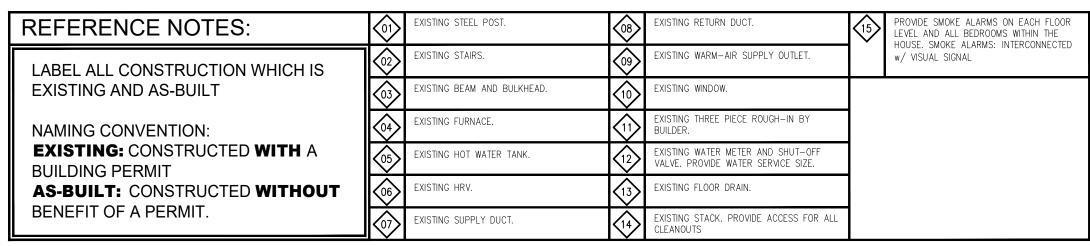


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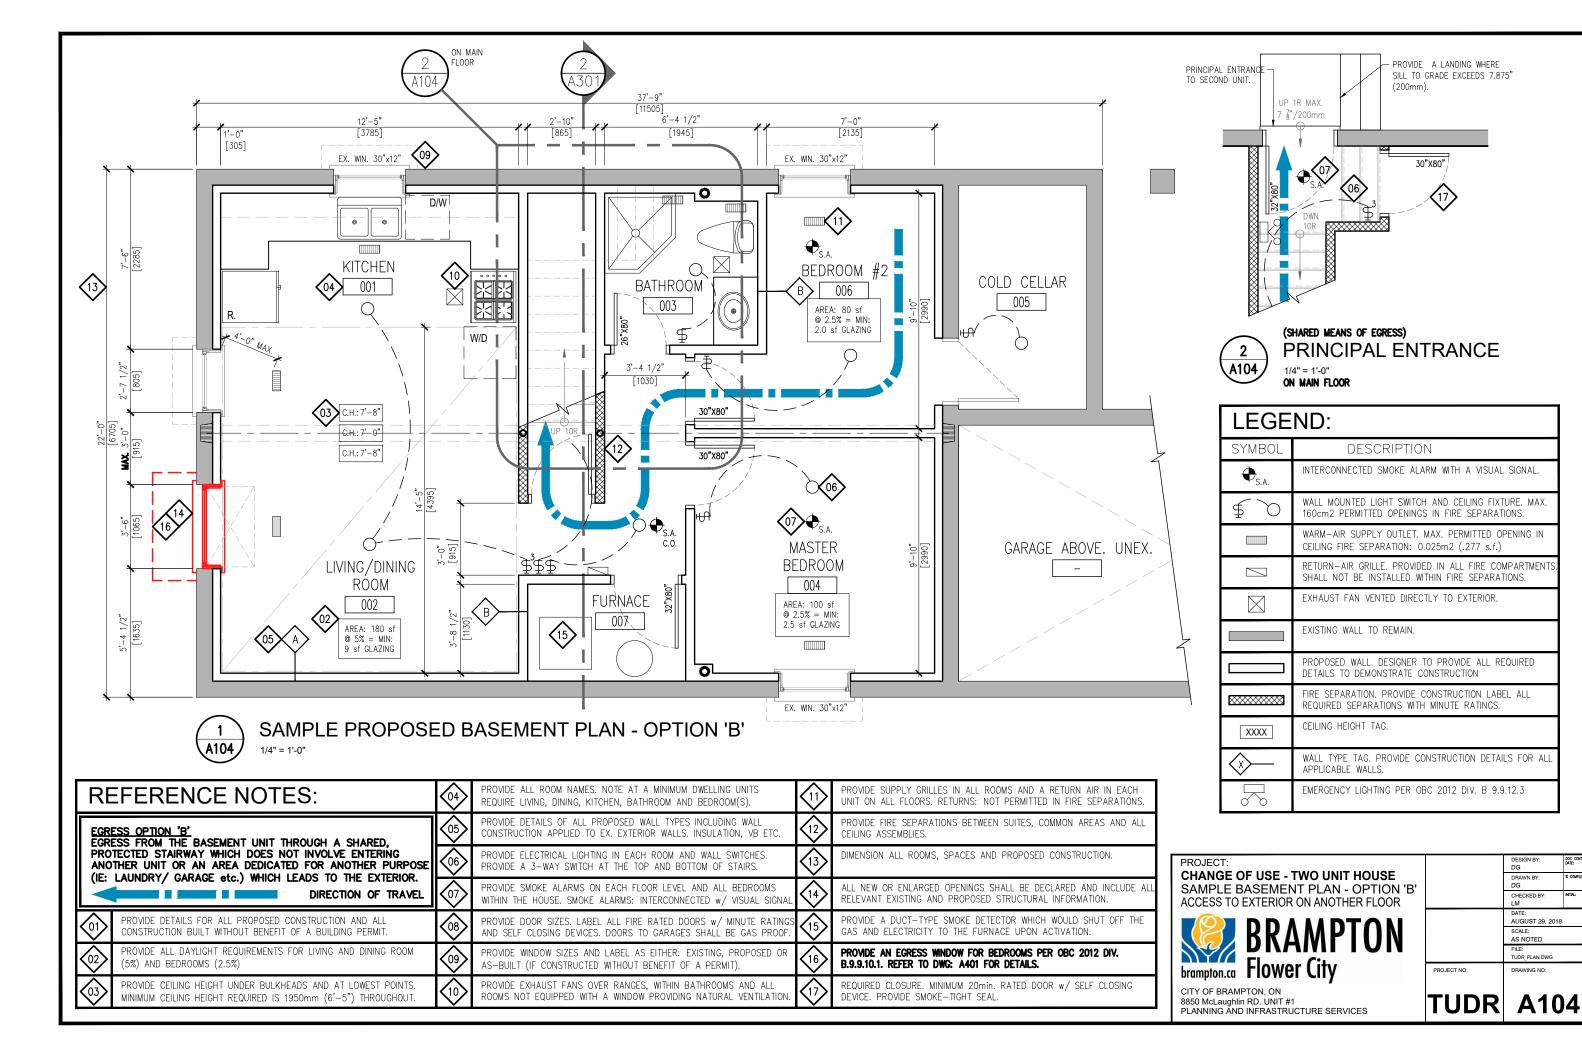
CHANGE OF USE - TWO UNIT HOUSE


SAMPLE EXISTING BASEMENT PLAN




| <b>TUDR</b> | A10                      | 2           |
|-------------|--------------------------|-------------|
| PROJECT NO: | DRAWING NO:              |             |
|             | FILE:<br>TUDR_PLAN.DWG   |             |
|             | SCALE:<br>AS NOTED       |             |
|             | DATE:<br>AUGUST 29, 2018 |             |
|             | CHECKED BY:<br>LM        | INITIAL:    |
|             | DRAWN BY:<br>DG          | % COMPLETE: |
|             | DG                       | DMIC.       |



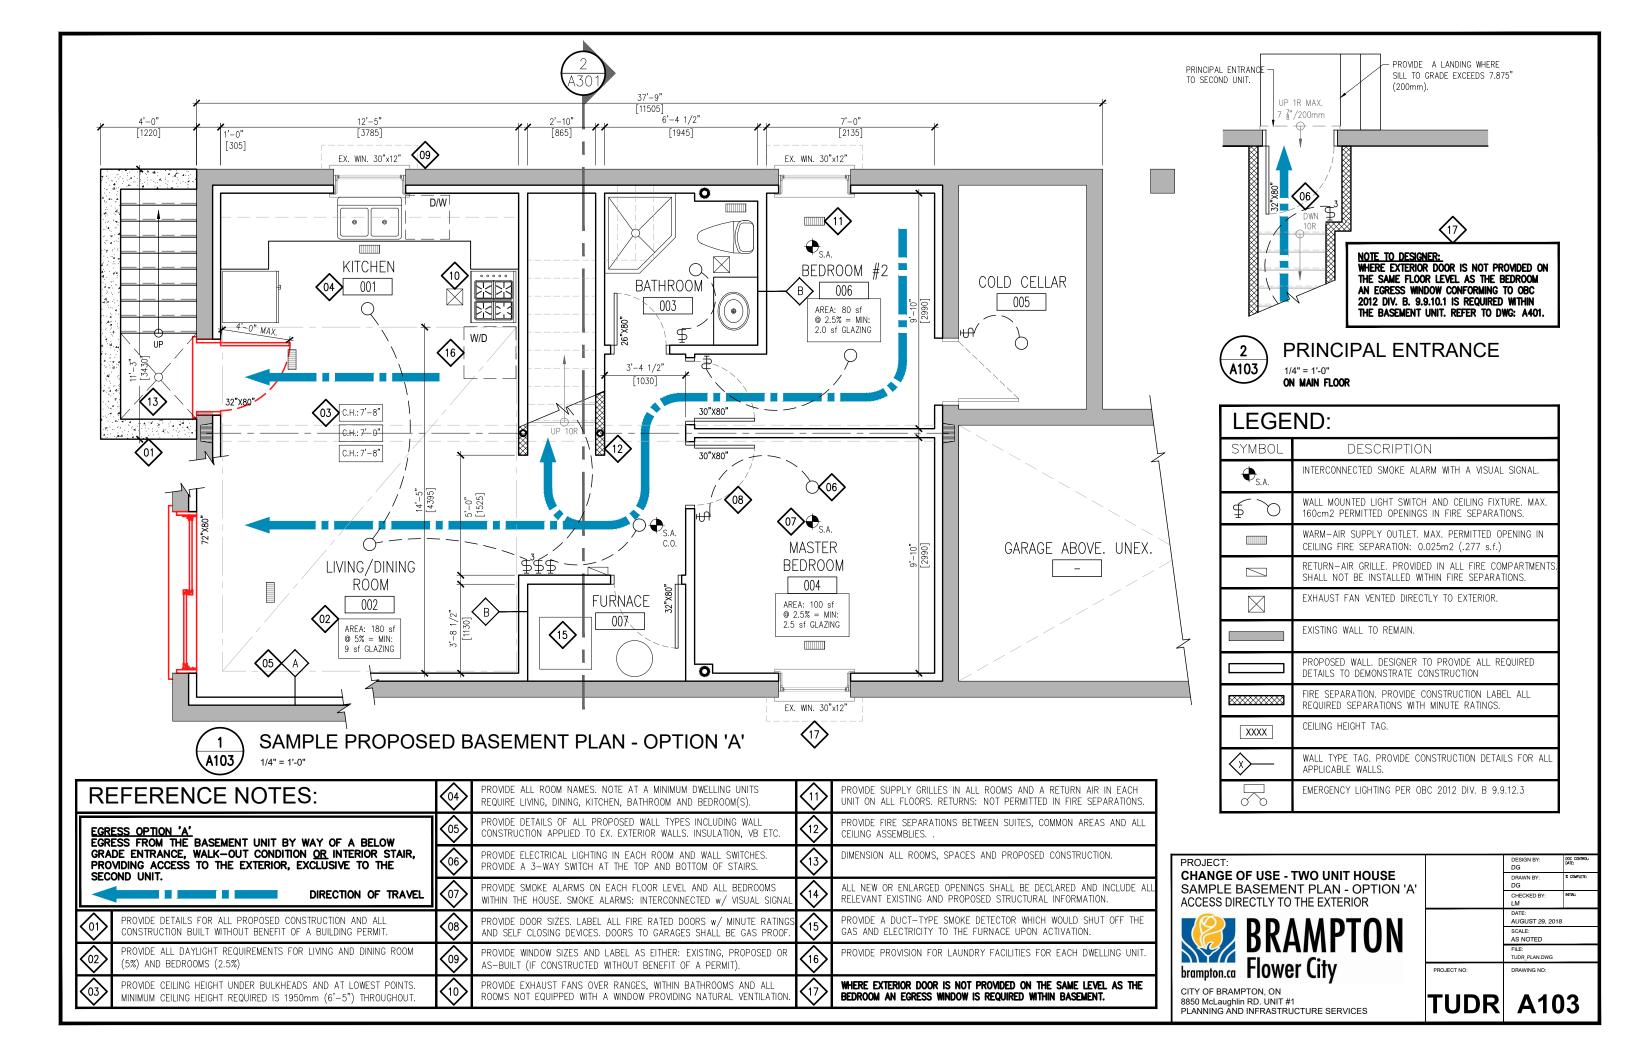

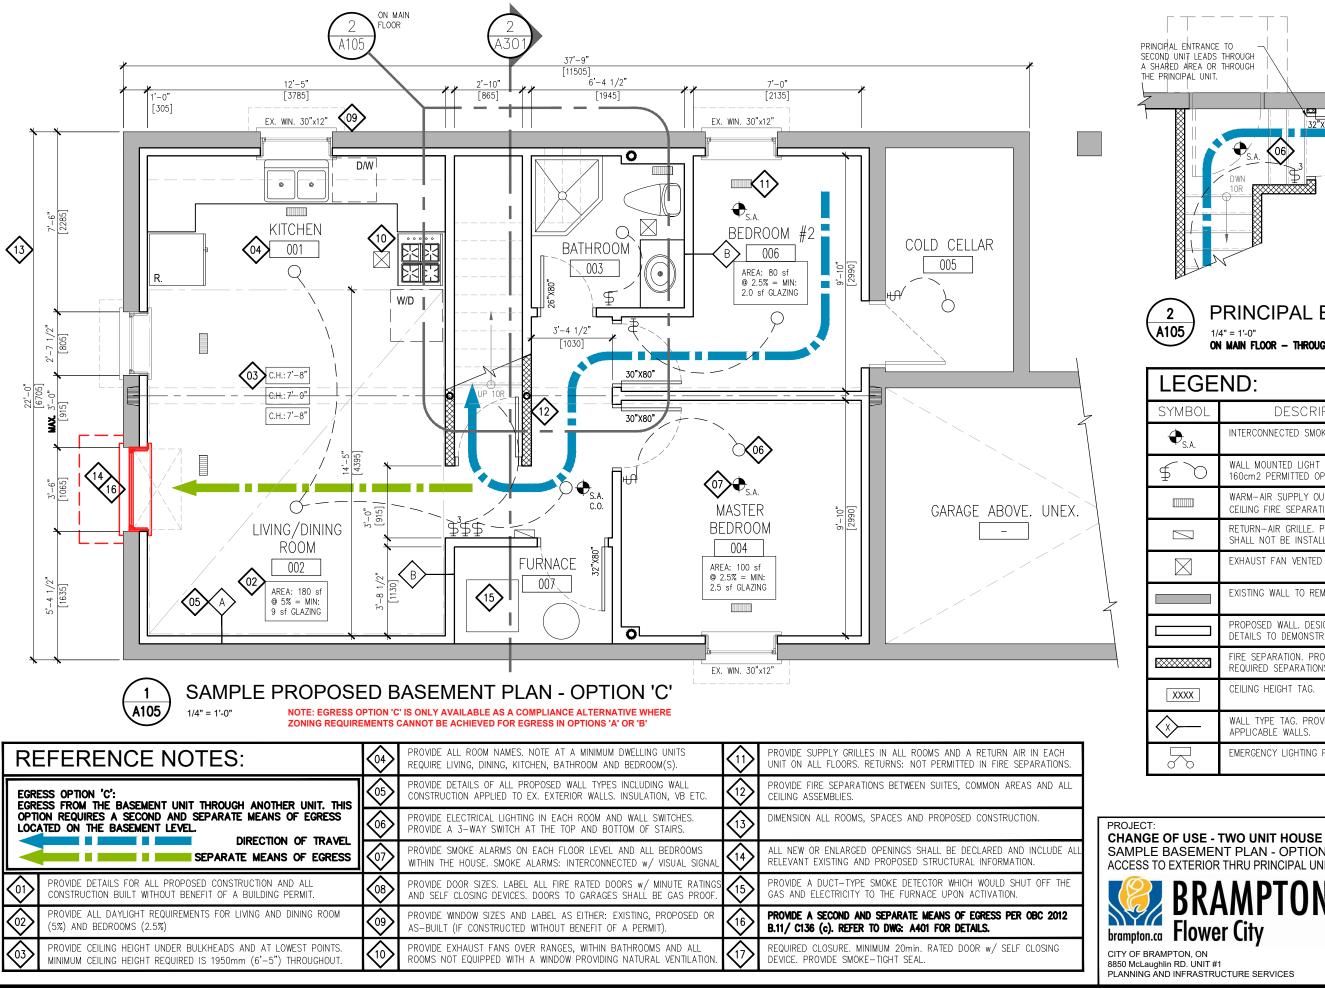

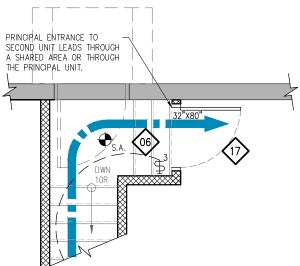

#### PRINCIPAL ENTRANCE

ON MAIN FLOOR - THROUGH ANOTHER UNIT


| LEGE              | LEGEND:  |  |  |  |  |  |
|-------------------|--|--|--|--|--|--|
| SYMBOL            | DESCRIPTION  |  |  |  |  |  |
| ⊕ <sub>S.A.</sub> | INTERCONNECTED SMOKE ALARM WITH A VISUAL SIGNAL.   |  |  |  |  |  |
| \$                | WALL MOUNTED LIGHT SWITCH AND CEILING FIXTURE. MAX.<br>160cm2 PERMITTED OPENINGS IN FIRE SEPARATIONS.    |  |  |  |  |  |
|                   | WARM-AIR SUPPLY OUTLET. MAX. PERMITTED OPENING IN CEILING FIRE SEPARATION: 0.025m2 (.277 s.f.)           |  |  |  |  |  |
|                   | RETURN—AIR GRILLE. PROVIDED IN ALL FIRE COMPARTMENTS.<br>SHALL NOT BE INSTALLED WITHIN FIRE SEPARATIONS. |  |  |  |  |  |
|                   | EXHAUST FAN VENTED DIRECTLY TO EXTERIOR.   |  |  |  |  |  |
|                   | EXISTING WALL TO REMAIN.   |  |  |  |  |  |
|                   | PROPOSED WALL. DESIGNER TO PROVIDE ALL REQUIRED DETAILS TO DEMONSTRATE CONSTRUCTION                      |  |  |  |  |  |
|                   | FIRE SEPARATION. PROVIDE CONSTRUCTION LABEL ALL REQUIRED SEPARATIONS WITH MINUTE RATINGS.                |  |  |  |  |  |
| XXXX              | CEILING HEIGHT TAG.  |  |  |  |  |  |
| <b>◇</b> —        | WALL TYPE TAG. PROVIDE CONSTRUCTION DETAILS FOR ALL APPLICABLE WALLS.                                    |  |  |  |  |  |
|                   | EMERGENCY LIGHTING PER OBC 2012 DIV. B 9.9.12.3  |  |  |  |  |  |

SAMPLE BASEMENT PLAN - OPTION 'C' ACCESS TO EXTERIOR THRU PRINCIPAL UNIT



CHECKED BY: AUGUST 29, 2018 AS NOTED FILE: TUDR\_PLAN.DWG

TUDR A105

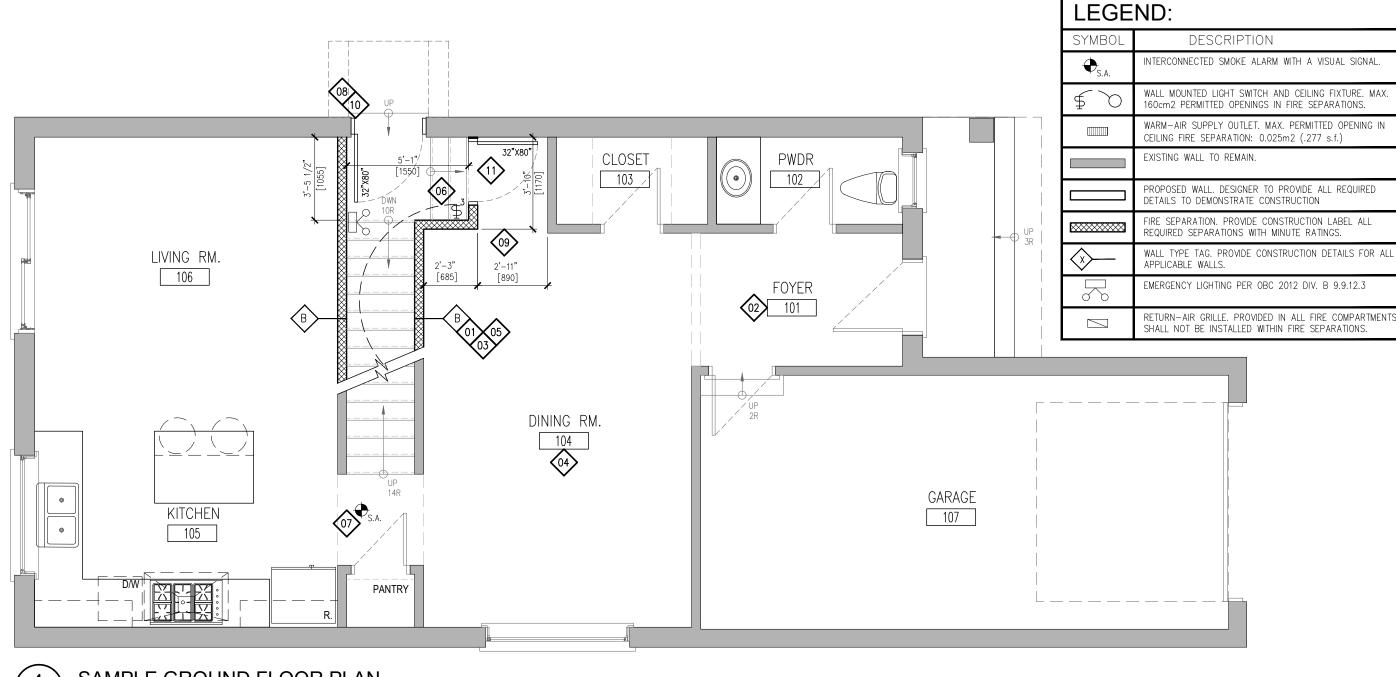





| RI           | FERENCE NOTES:   | <b>(</b> 07 <b>)</b> | PROVIDE SMOKE ALARMS ON EACH FLOOR LEVEL AND ALL BEDROOMS WITHIN THE HOUSE. SMOKE ALARMS: INTERCONNECTED w/ VISUAL SIGNAL          |
|--------------|--|----------------------|--|
| <b>(</b> 01) | PROVIDE DETAILS FOR ALL PROPOSED CONSTRUCTION AND ALL CONSTRUCTION BUILT WITHOUT BENEFIT OF A BUILDING PERMIT.               | <b>⊗</b>             | PROVIDE DOOR SIZES. LABEL ALL FIRE RATED DOORS W/ MINUTE RATINGS<br>AND SELF CLOSING DEVICES. DOORS TO GARAGES SHALL BE GAS PROOF. |
| <u> </u>     | PROVIDE SUPPLY GRILLES IN ALL ROOMS AND A RETURN AIR IN EACH UNIT ON ALL FLOORS. RETURNS: NOT PERMITTED IN FIRE SEPARATIONS. | <b>(99)</b>          | DIMENSION ALL ROOMS, SPACES AND PROPOSED CONSTRUCTION.   |
| <b>(</b> 3)  | PROVIDE FIRE SEPARATIONS BETWEEN SUITES, COMMON AREAS AND ALL CEILING ASSEMBLIES. VERTICAL: MIN. 30min/ HORIZONTAL: 15min.   | 10>                  | ALL NEW OR ENLARGED OPENINGS SHALL BE DECLARED AND INCLUDE AL RELEVANT EXISTING AND PROPOSED STRUCTURAL INFORMATION.               |
| 04           | PROVIDE ALL ROOM NAMES. NOTE AT A MINIMUM DWELLING UNITS REQUIRE LIVING, DINING, KITCHEN, BATHROOM AND BEDROOM(S).           | 11>                  | REQUIRED CLOSURE. MINIMUM 20min. RATED DOOR w/ SELF CLOSING DEVICE. PROVIDE SMOKE-TIGHT SEAL.                                      |
| 05           | PROVIDE DETAILS OF ALL PROPOSED WALL TYPES INCLUDING WALL CONSTRUCTION APPLIED TO EX. EXTERIOR WALLS. INSULATION, VB ETC.    |                      |  |
| <b>6</b>     | PROVIDE ALL ELECTRICAL LIGHTING FACILITIES AND WALL SWITCHES.<br>PROVIDE A 3-WAY SWITCH AT THE TOP AND BOTTOM OF STAIRS.     |                      |  |

PROJECT:
CHANGE OF USE - TWO UNIT HOUSE
SAMPLE GROUND FLOOR PLAN

| $\gamma \gamma \gamma \prime \prime$ | <b>BRAMPTON</b> Flower City |
|--------------------------------------|-----------------------------|
|--------------------------------------|-----------------------------|

| TUDR        | A10                     | )6                    |
|-------------|-------------------------|-----------------------|
| PROJECT NO: | DRAWING NO:             |                       |
|             | FILE:<br>TUDR_PLAN.DWG  |                       |
|             | SCALE:<br>AS NOTED      |                       |
|             | DATE:<br>AUGUST 29, 201 | 8                     |
|             | CHECKED BY:<br>LM       | INITIAL:              |
|             | DRAWN BY:<br>DG         | % COMPLETE:           |
|             | DESIGN BY:<br>DG        | DOC CONTROL:<br>DATE: |

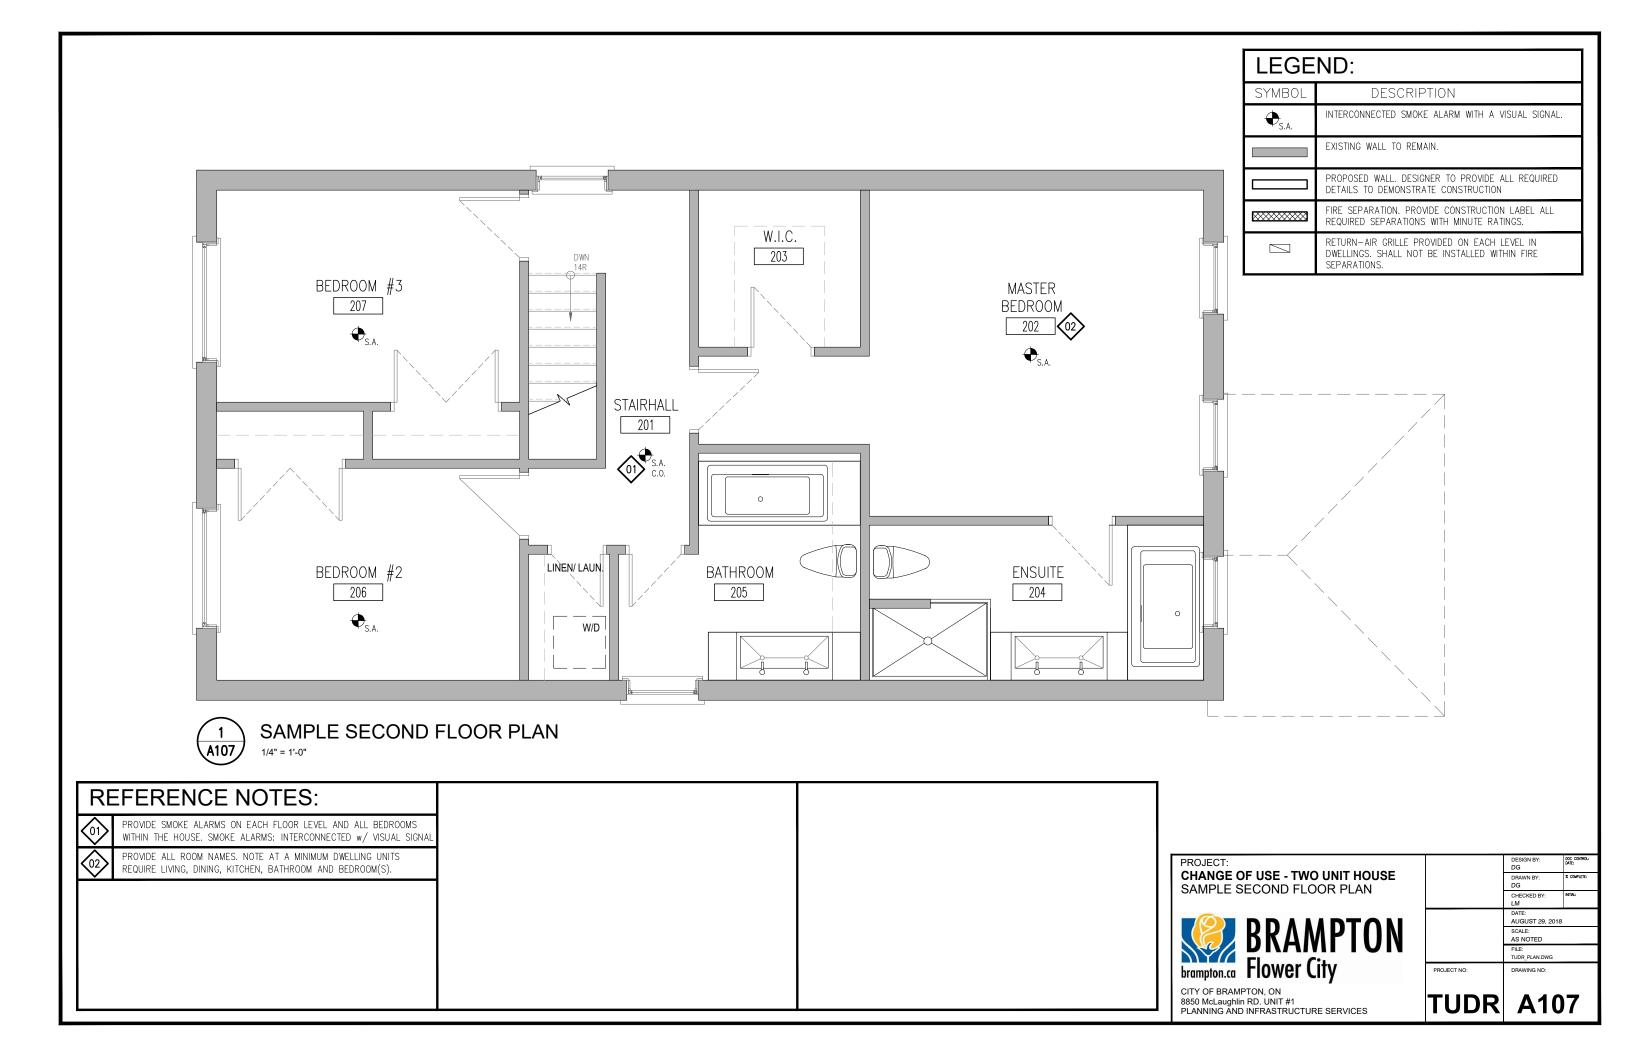

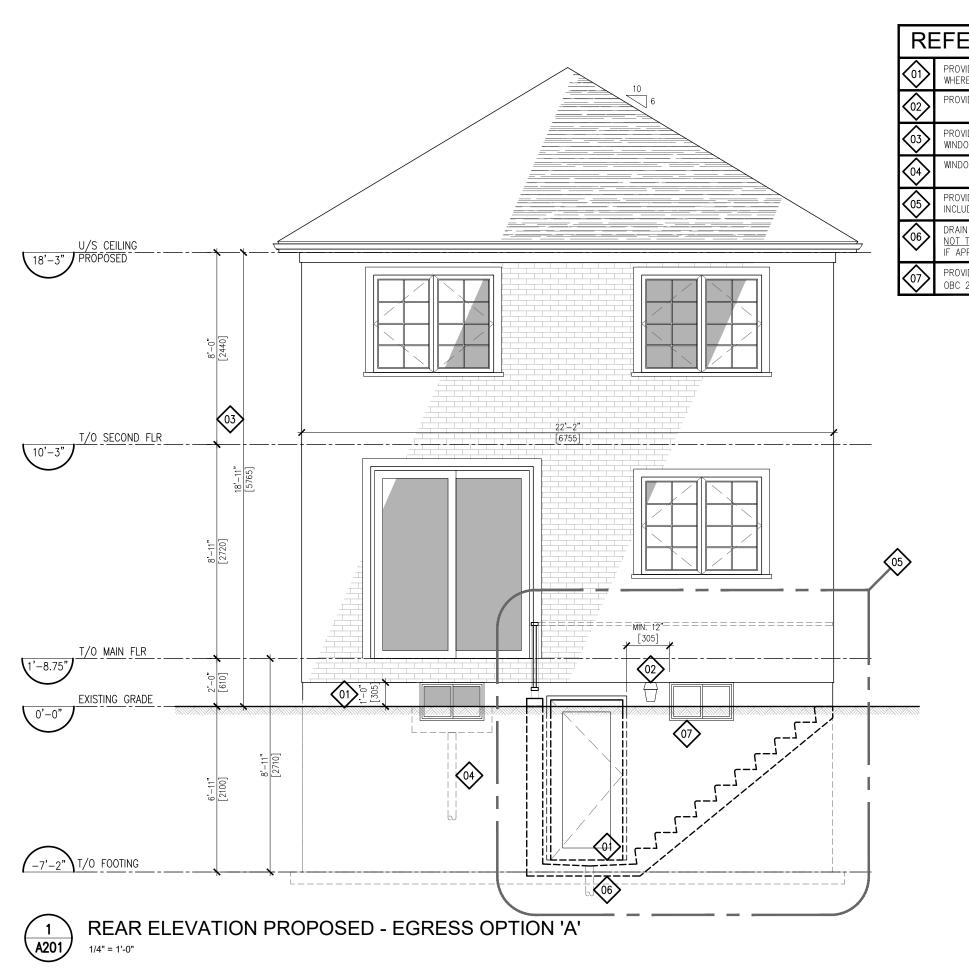



PROVIDE DIMENSION FROM DOOR SILL TO ADJACENT SLAB/ GRADE WHERE DOOR IS TO BE USED AS PRINCIPAL ENTRANCE.

PROVIDE AN EXTERIOR LIGHT FIXTURE AND INTERIOR SWITCH.

PROVIDE DIMENSIONS OF WALL/ WALL AREA. INCLUDE ALL EXIST,/ PROP. WINDOW SIZES AND AREA ABOVE GRADE FOR BASEMENT WINDOWS.

WINDOW WELLS ARE TO DRAIN TO EXTERIOR.

PROVIDE ALL REQUIRED DETAILS FOR BELOW GRADE ENTRANCE. INCLUDE ALL DETAILS FOR GUARD CONSTRUCTION AND CONNECTIONS.

DRAIN IS TO CONNECT DIRECTLY TO SUMP PUMP OR STORM DRAIN.

NOT TO WEEPING TILE OR SANITARY DRAIN. PROVIDE SUMP LOCATION

IF APPLICABLE.

PROVIDE PROTECTION OVER WINDOWS PER ARTICLE: 9.8.8.1(8). OF THE OBC 2012 (DIV. B) WITHIN REQUIRED AREA OF GUARDS.

PROJECT:

CHANGE OF USE - TWO UNIT HOUSE


SAMPLE REAR ELEVATION




CITY OF BRAMPTON, ON 8850 McLaughlin RD. UNIT #1 PLANNING AND INFRASTRUCTURE SERVICES

|             | DESIGN BY:<br>DG           | DOC CONTROL:<br>DATE: |  |
|-------------|----------------------------|-----------------------|--|
|             | DRAWN BY:<br>DG            | % COMPLETE:           |  |
|             | CHECKED BY:<br>LM          | INITIAL:              |  |
|             | DATE:<br>JANUARY 9th, 2019 |                       |  |
|             | SCALE:<br>AS NOTED         |                       |  |
|             | FILE:<br>TUDR_PLAN.DWG     |                       |  |
| PROJECT NO: | DRAWING NO:                |                       |  |

TUDR A201

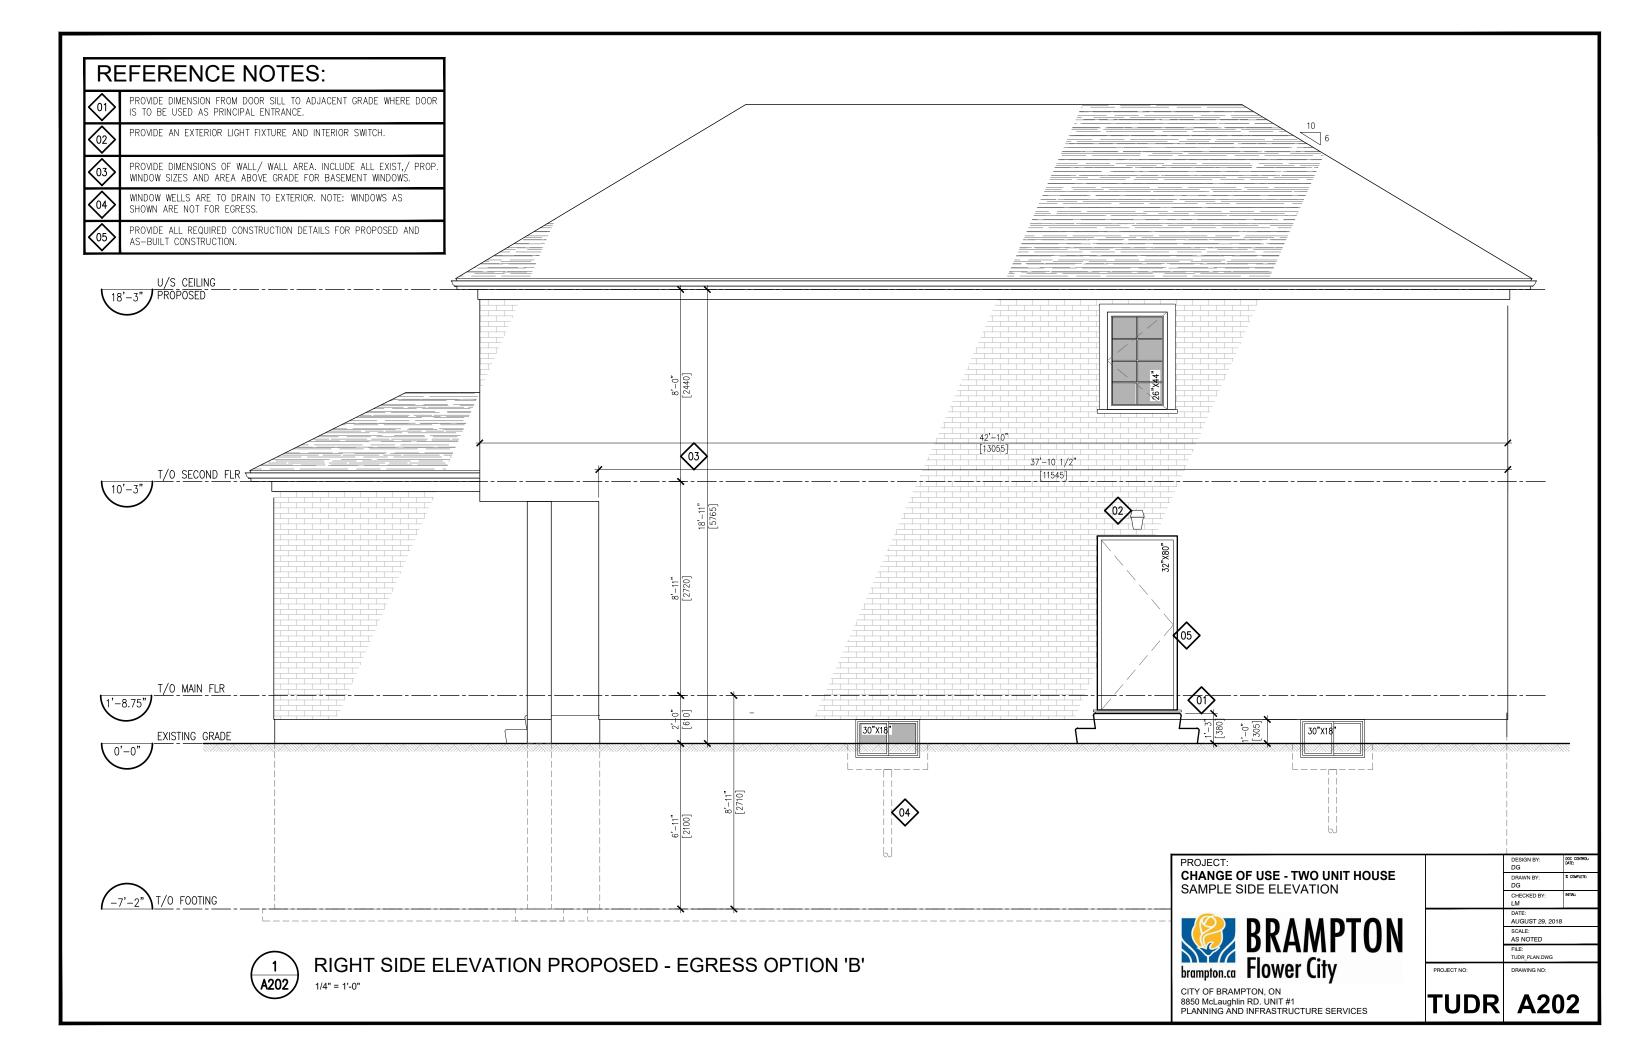


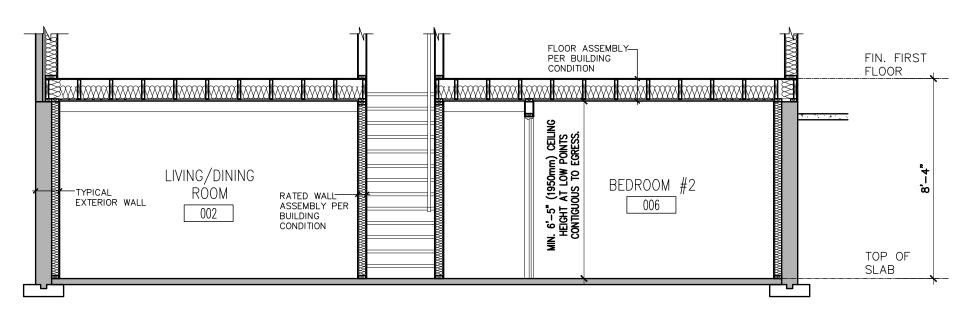



### **BASEMENT SECTION**


1/4" = 1'-0"

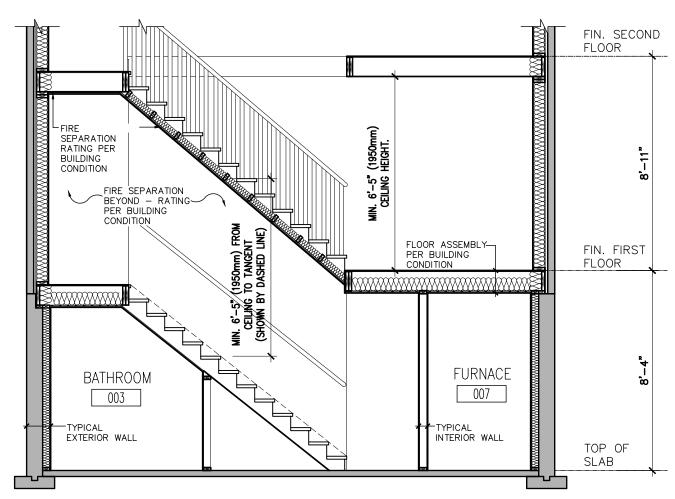



# STAIR SECTION

1/4" = 1'-0"

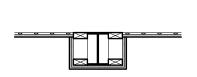


2"x4" WOOD FRAMING 2 LAYERS TYPE 'X' GYPSUM BOARD RATING PER BUILDING CONDITION

#### STEEL BEAM **SEPARATION**




STEEL COLUMN **SEPARATION** 

2"x4" WOOD STUDS 2 LAYERS TYPE 'X' GYPSUM BOARD RATING PER BUILDING CONDITION

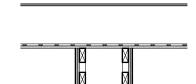

FIRE SEPARATION CEILING ABOVE 2"x4" WOOD STUDS 1/2" GYPSUM BOARD

#### **BULKHEAD BELOW** FIRE SEPARATION

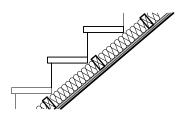


2"x4" WOOD STUDS TO SUPPORT CEILING SOUND INSULATION (OPTIONAL) 2 LAYERS TYPE 'X' GYPSUM BOARD RATING PER BUILDING CONDITION

#### **UNDERSIDE OF STAIR** FIRE SEPARATION




DRAWN BY CHECKED BY: DATE: AUGUST 29, 2018 SCALE: AS NOTED FILE: TUDR\_PLAN.DWG PROJECT NO: DRAWING NO: A301

TUDR

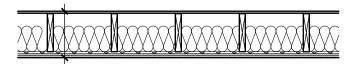


15.5mm PLYWOOD, OSB, OR
WAFERBOARD SUBFLOOR
WOOD JOISTS OR WOOD I—JOISTS
SPACED NOT MORE THAN 610mm O.C.
ABSORPTIVE MATERIAL IN CAVITY
RESILIENT CHANNELS @ 610mm O.C.
2 LAYERS 12.7mm TYPE 'X' GYPSUM BOARD

FLOOR ASSEMBLY F9h FRR - 45 MIN. STC - 53 BUILDING CONDITION A

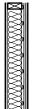


5/8" TYPE 'X' GYPSUM BOARD 2"x4" OR 2"x6" @ 16" O/C WOOD STUDS 3 1/2" SOUND INSULATION RESILIENT METAL CHANNELS @ 16" OR 24" O/C 2 LAYERS 5/8" TYPE 'X' GYPSUM BOARD

WALL ASSEMBLY W4a FRR - 1 HOUR STC - 51 BUILDING CONDITION A

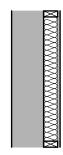


EXTERIOR FOUNDATION WALL 2"x4" OR 2"x6" @ 16" O/C WOOD STUDS
MIN. R12 BATT INSULATION
6 MIL. POLY VAPOUR BARRIER 1/2" GYPSUM BOARD

TYPICAL EXTERIOR WALL

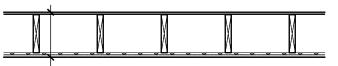


EXISTING PLYWOOD, OSB, OR
WAFERBOARD SUBFLOOR
WOOD JOISTS OR WOOD I-JOISTS
SPACED NOT MORE THAN 610mm O.C.
NO ABSORPTIVE MATERIAL IN CAVITY
(OPTIONAL 6" SOUND INSULATION)
RESILIENT CHANNELS @ 610mm O.C.
15.9mm TYPE 'X' GYPSUM BOARD

FLOOR ASSEMBLY F8b FRR - 30 MIN. STC - 43 BUILDING CONDITION B

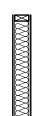


1/2" GYPSUM BOARD
2"x4" OR 2"x6" @ 16" O/C
WOOD STUDS
ENTIRE STUD CAVITY FILLED
WITH SOUND INSULATION
1/2" GYPSUM BOARD

WALL ASSEMBLY W1c FRR - 30 MIN. STC - N/A BUILDING CONDITION B

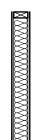


1/2" GYPSUM BOARD
2"x4" OR 2"x6" @ 16" O/C
WOOD STUDS
ENTIRE STUD CAVITY FILLED
WITH SOUND INSULATION
(OPTIONAL)
1/2" GYPSUM BOARD

TYPICAL INTERIOR WALL

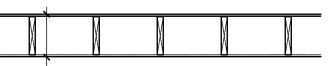

EXISTING SUBFLOOR
EXISTING WOOD JOISTS OR WOOD
I—JOISTS
NO ABSORPTIVE MATERIAL IN
CAVITY
12.7mm GYPSUM BOARD

EXISTING FLOOR ASSEMBLY FRR - 15 MIN. STC - N/A BUILDING CONDITION C

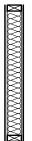

1/2" GYPSUM BOARD
2"x4" OR 2"x6" @ 16" O/C
WOOD STUDS
ENTIRE STUD CAVITY FILLED
WITH SOUND INSULATION
(OPTIONAL)
1/2" GYPSUM BOARD

EXISTING RATED WALL FRR - 30 MIN. STC - N/A BUILDING CONDITION C


WALL TYPES DEMONSTRATED ON THIS DRAWING ARE BASED ON WALL CONSTRUCTION DETAILS SPECIFIED IN THE SUPPLEMENTARY STANDARD SB-3. DESIGNER IS REQUIRED TO SPECIFY THE MINUTE RATING AND CONSTRUCTION OF ALL REQUIRED FIRE SEPARATIONS.

PROJECT:
CHANGE OF USE - TWO UNIT HOUSE
WALL/ CEILING ASSEMBLIES

BRAMPTON
brampton.ca Flower City

CITY OF BRAMPTON, ON 8850 McLaughlin RD. UNIT #1 PLANNING AND INFRASTRUCTURE SERVICES DESIGN BY:
DS
DRAWN BY:
DS
DRAWN BY:
TOWNETE
DS
CHECKED BY:
LM
DATE:
AUGUST 29, 2018
SCALE:
AS NOTED
FILE:
TUDR\_PLAN.DWG
PROJECT NO:
DRAWING NO:


TUDR A302

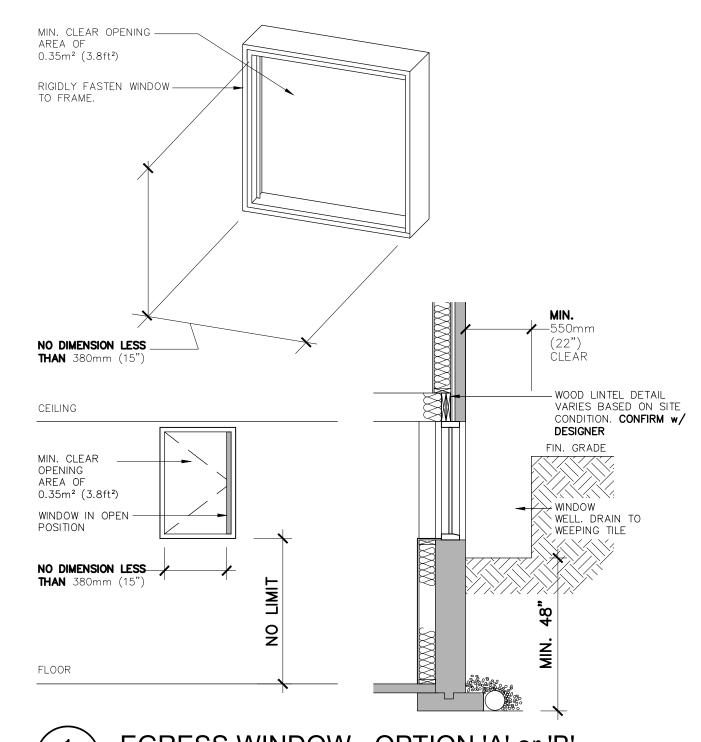



EGRESS WINDOW - OPTION 'A' or 'B'


3/8" = 1'-0"

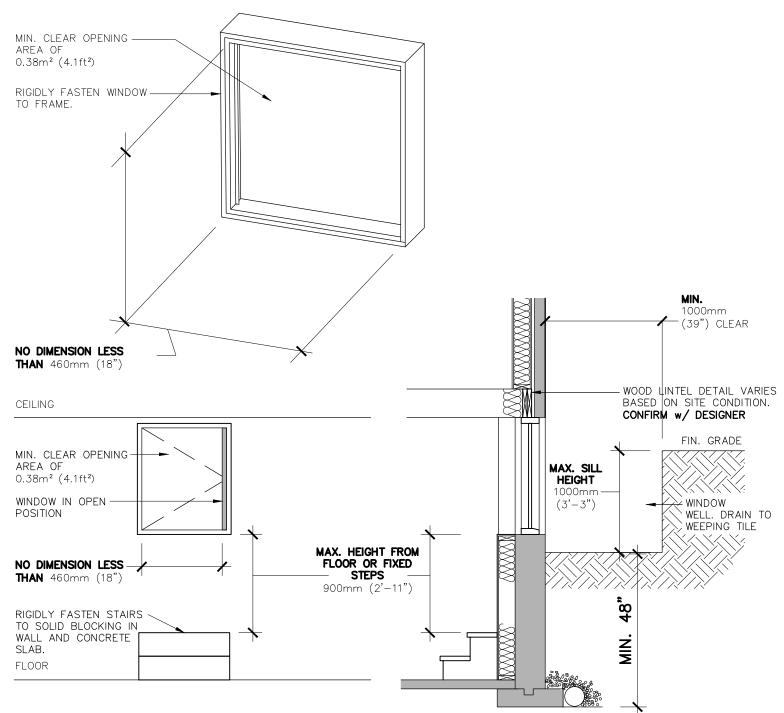






## **ESCAPE WINDOW - OPTION 'C'**

3/8" = 1'-0" NOTE: EGRESS OPTION 'C' IS ONLY AVAILABLE AS A COMPLIANCE ALTERNATIVE WHERE ZONING REQUIREMENTS CANNOT BE ACHIEVED FOR EGRESS IN OPTIONS 'A' OR 'B'

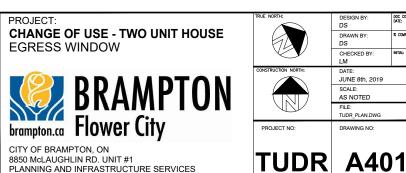


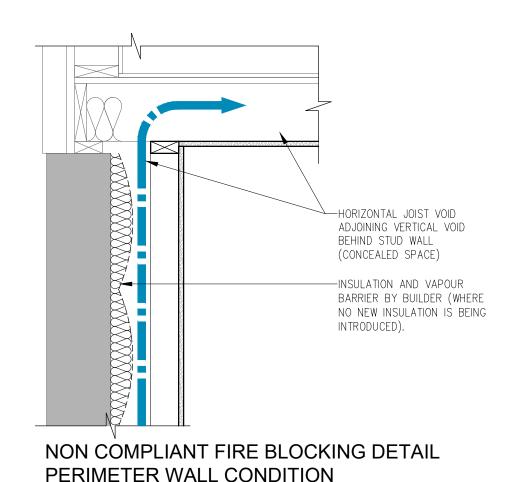

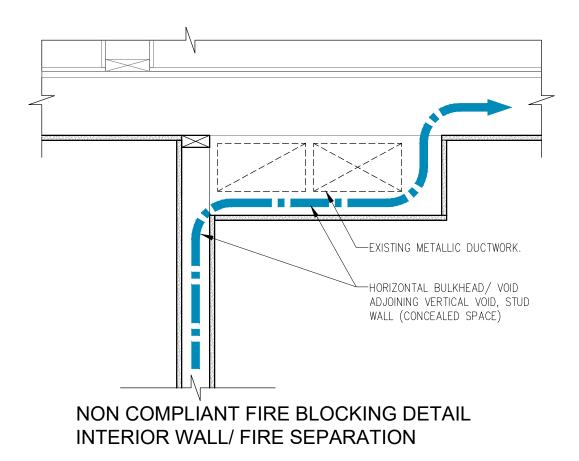

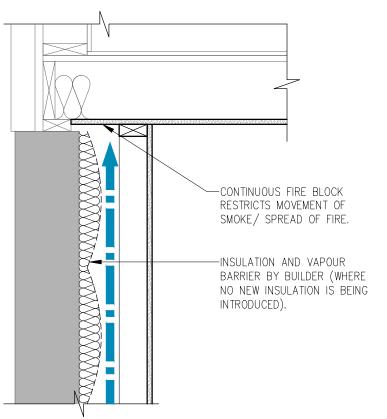

# COMPLIANT FIRE BLOCKING DETAIL PERIMETER WALL CONDITION

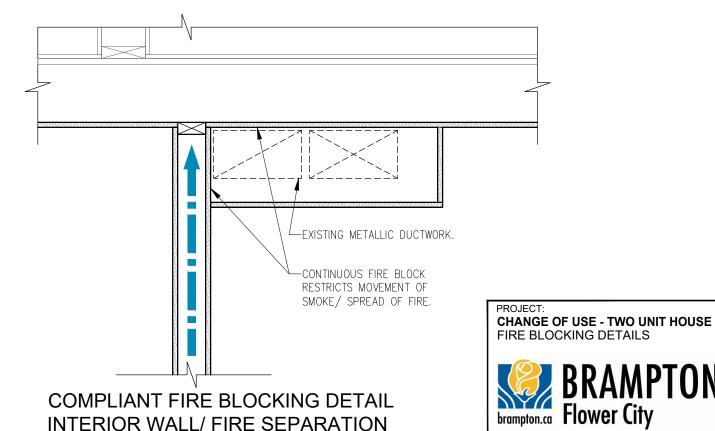

## 9.10.16.1. REQUIRED FIRE BLOCKS IN CONCEALED SPACES:

- (1) CONCEALED SPACES IN INTERIOR WALLS, CEILINGS, FLOORS AND CRAWL SPACES SHALL BE SEPARATED BY FIRE BLOCKS FROM CONCEALED SPACES IN EXTERIOR WALLS AND ATTIC OR ROOF SPACES.
- (2) FIRE BLOCKS SHALL BE PROVIDED AT ALL INTERCONNECTIONS BETWEEN CONCEALED VERTICAL AND HORIZONTAL SPACES IN INTERIOR COVED CEILINGS, DROP CEILINGS AND SOFFITS WHERE THE EXPOSED CONSTRUCTION MATERIALS WITHIN THE CONCEALED SPACES HAVE A SURFACE FLAME—SPREAD RATING GREATER THAN 25.
- (3) FIRE BLOCKS SHALL BE PROVIDED AT THE TOP AND BOTTOM OF EACH RUN OF STAIRS WHERE THEY PASS THROUGH A FLOOR CONTAINING CONCEALED SPACE IN WHICH THE EXPOSED CONSTRUCTION MATERIALS WITHIN THE SPACE HAVE A SURFACE FLAMESPREAD RATING GREATER THAN 25.

MOVEMENT OF SMOKE/ SPREAD OF FIRE

> DRAWN BY: DG


CHECKED BY: LM DATE: JUNE 8th, 2019 SCALE: AS NOTED

FILE: TUDR\_PLAN.DW

**TUDR A402** 

PROJECT NO:

# FOR REFERENCE ONLY

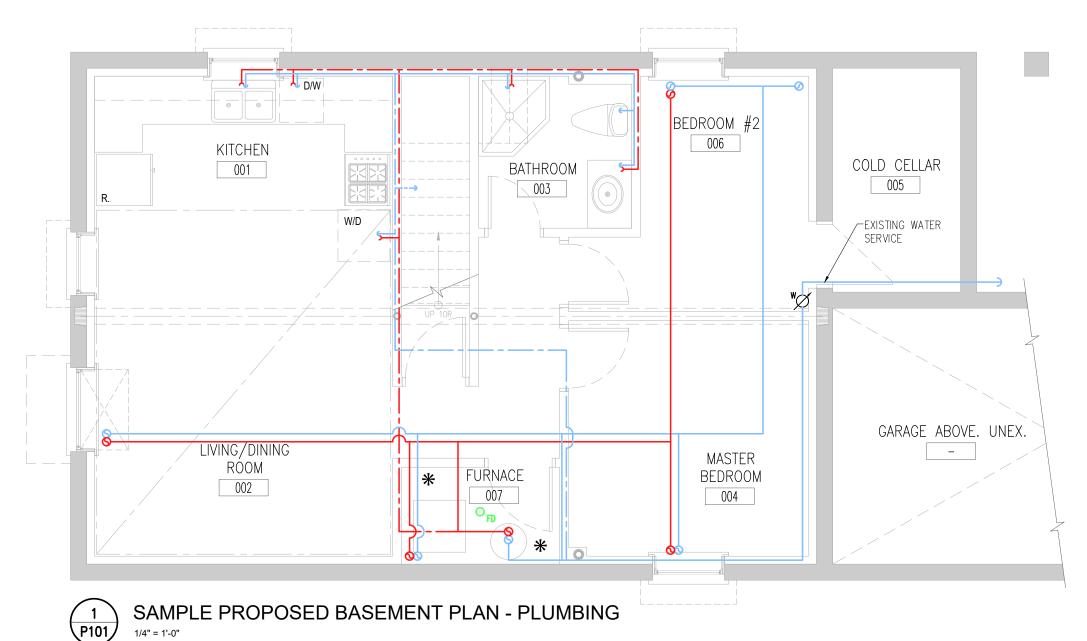

| LEGEND:                    |   |  |  |  |
|----------------------------|---|--|--|--|
| SYMBOL                     | DESCRIPTION (SEE PLAN FOR PIPE SIZES)                       |  |  |  |
|                            | PROPOSED HOT WATER LINE AND RISER UNIT 1 (MAIN FLOOR).      |  |  |  |
|                            | PROPOSED COLD WATER LINE AND RISER UNIT 1 (MAIN FLOOR).     |  |  |  |
| <b>—</b> ©                 | PROPOSED HOT WATER LINE AND RISER UNIT 2 (BASEMENT SUITE).  |  |  |  |
|                            | PROPOSED COLD WATER LINE AND RISER UNIT 2 (BASEMENT SUITE). |  |  |  |
|                            | SEPARATE UNIT SUPPLY LINES CROSSING.                        |  |  |  |
| *                          | RESIDENTIAL SPRINKLER HEAD                                  |  |  |  |
| O <sub>FD</sub>            | FLOOR DRAIN.  |  |  |  |
| $\varnothing_{\mathtt{w}}$ | WATER METER. PROVIDE SUPPLY PIPE<br>SIZE/ DIAMETER.         |  |  |  |

#### **REFERENCE NOTES:**

#### NOTES:

- 1. SHUT-OFF VALVES SHALL BE INSTALLED ON THE WATER SUPPLY TO EACH UNIT TO ENSURE THAT WHEN THE SUPPLY TO ONE UNIT IS SHUT OFF, THE SUPPLY TO THE OTHER IS NOT INTERRUPTED.
- 2. REFER TO OBC 2012 DIV. B 9.23.5 FOR NOTCHING AND DRILLING OF WOOD STRUCTURAL MEMBERS.

| PROJECT:  CHANGE OF USE - TWO UNIT HOUSE  SAMPLE BASEMENT PLAN - PLUMBING |
|---|
| RRAMPTON  |

BRAMPTON Flower City

|    | TUDR        | P10                     | 1                     |
|----|-------------|-------------------------|-----------------------|
|    | PROJECT NO: | DRAWING NO:             |                       |
|    |             | FILE:<br>TUDR_PLAN.DWG  |                       |
|    |             | SCALE:<br>AS NOTED      |                       |
|    |             | DATE:<br>MARCH 28, 2019 |                       |
| U  |             | CHECKED BY:<br>LM       | INITIAL:              |
| IG |             | DRAWN BY:<br>DG         | % COMPLETE:           |
|    |             | DESIGN BY:<br>DG        | DOC CONTROL:<br>DATE: |

